

# CODE & DESIGN COMPLIANCE


1. A.B. BUILDING CODE, PART 3
  - a. ROOF LIVE LOAD = 42 psf
  - b. FLOOR LIVE LOAD = 50 psf
2. CANADIAN ELECTRICAL CODE
3. NATIONAL PLUMBING CODE

# LEGEND

- [PSSI] PLANT SUPPLIED SITE INSTALLED  
 [SSSI] SITE SUPPLIED SITE INSTALLED  
 [OC] ON CENTER  
 [AFF] ABOVE FINISHED FLOOR  
 [BSC] BELOW STRUCTURAL CEILING  
 [RO] ROUGH OPENING  
 [TBA] TO BE ANNOUNCED

# LABELS

1. ATCO MANUFACTURING LABEL
2. CSA ELECTRICAL LABEL
3. ATCO SERIAL NUMBER STENCIL
4. MBI DECAL

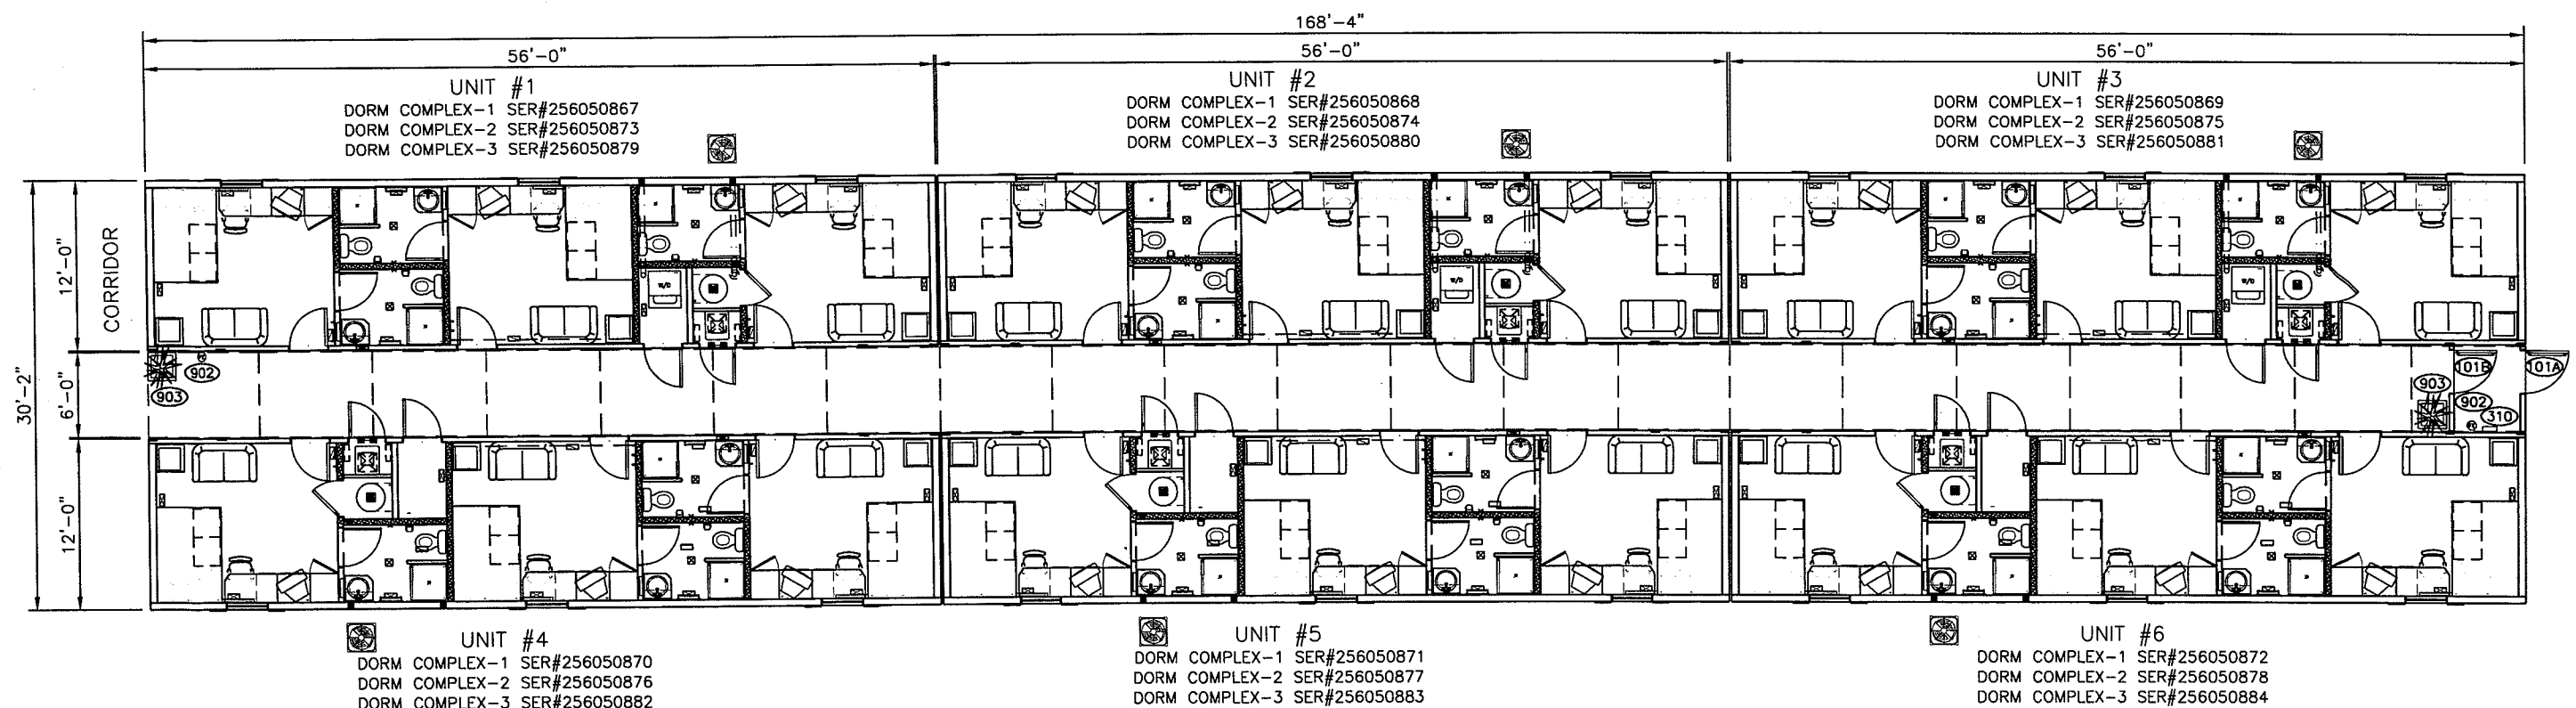

REV	DATE	DESCRIPTION	BY	CHK	APP
0	29AUG05	ISSUE FOR ACCEPTANCE	EM		

NOTES:

Client Acceptance Issue

AUG 29 2005

CUSTOMER ACCEPTANCE

☐ - ACCEPTANCE AS DRAWN  
☐ - ACCEPTANCE EXCEPT AS NOTED

BY: \_\_\_\_\_

DATE: \_\_\_\_\_

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DRAWN BY: EM  
 DATE: 15AUG05  
 SCALE: 1"=12'-0"  
 CHECKED BY: \_\_\_\_\_ DATE: \_\_\_\_\_  
 APPROVED BY: \_\_\_\_\_ DATE: \_\_\_\_\_

CLIENT: DEVON CANADA  
 54-PERSON PERMANENT CAMP  
 JACKFISH PROJECT


PROJECT: 6-12x56 UNIT DORM COMPLEX  
 [3-DORM COMPLEX]

INTERNAL DOCUMENT CONTROL

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 REDLINE REC'D BY ENG BY: \_\_\_\_\_ DATE: \_\_\_\_\_  
 DRAWING TITLE: DORMITORY COMPLEX  
 FLOOR PLAN

DRAWING NO: B-95355-01-A00  
 REVISION: 0

**ATCO** Structures

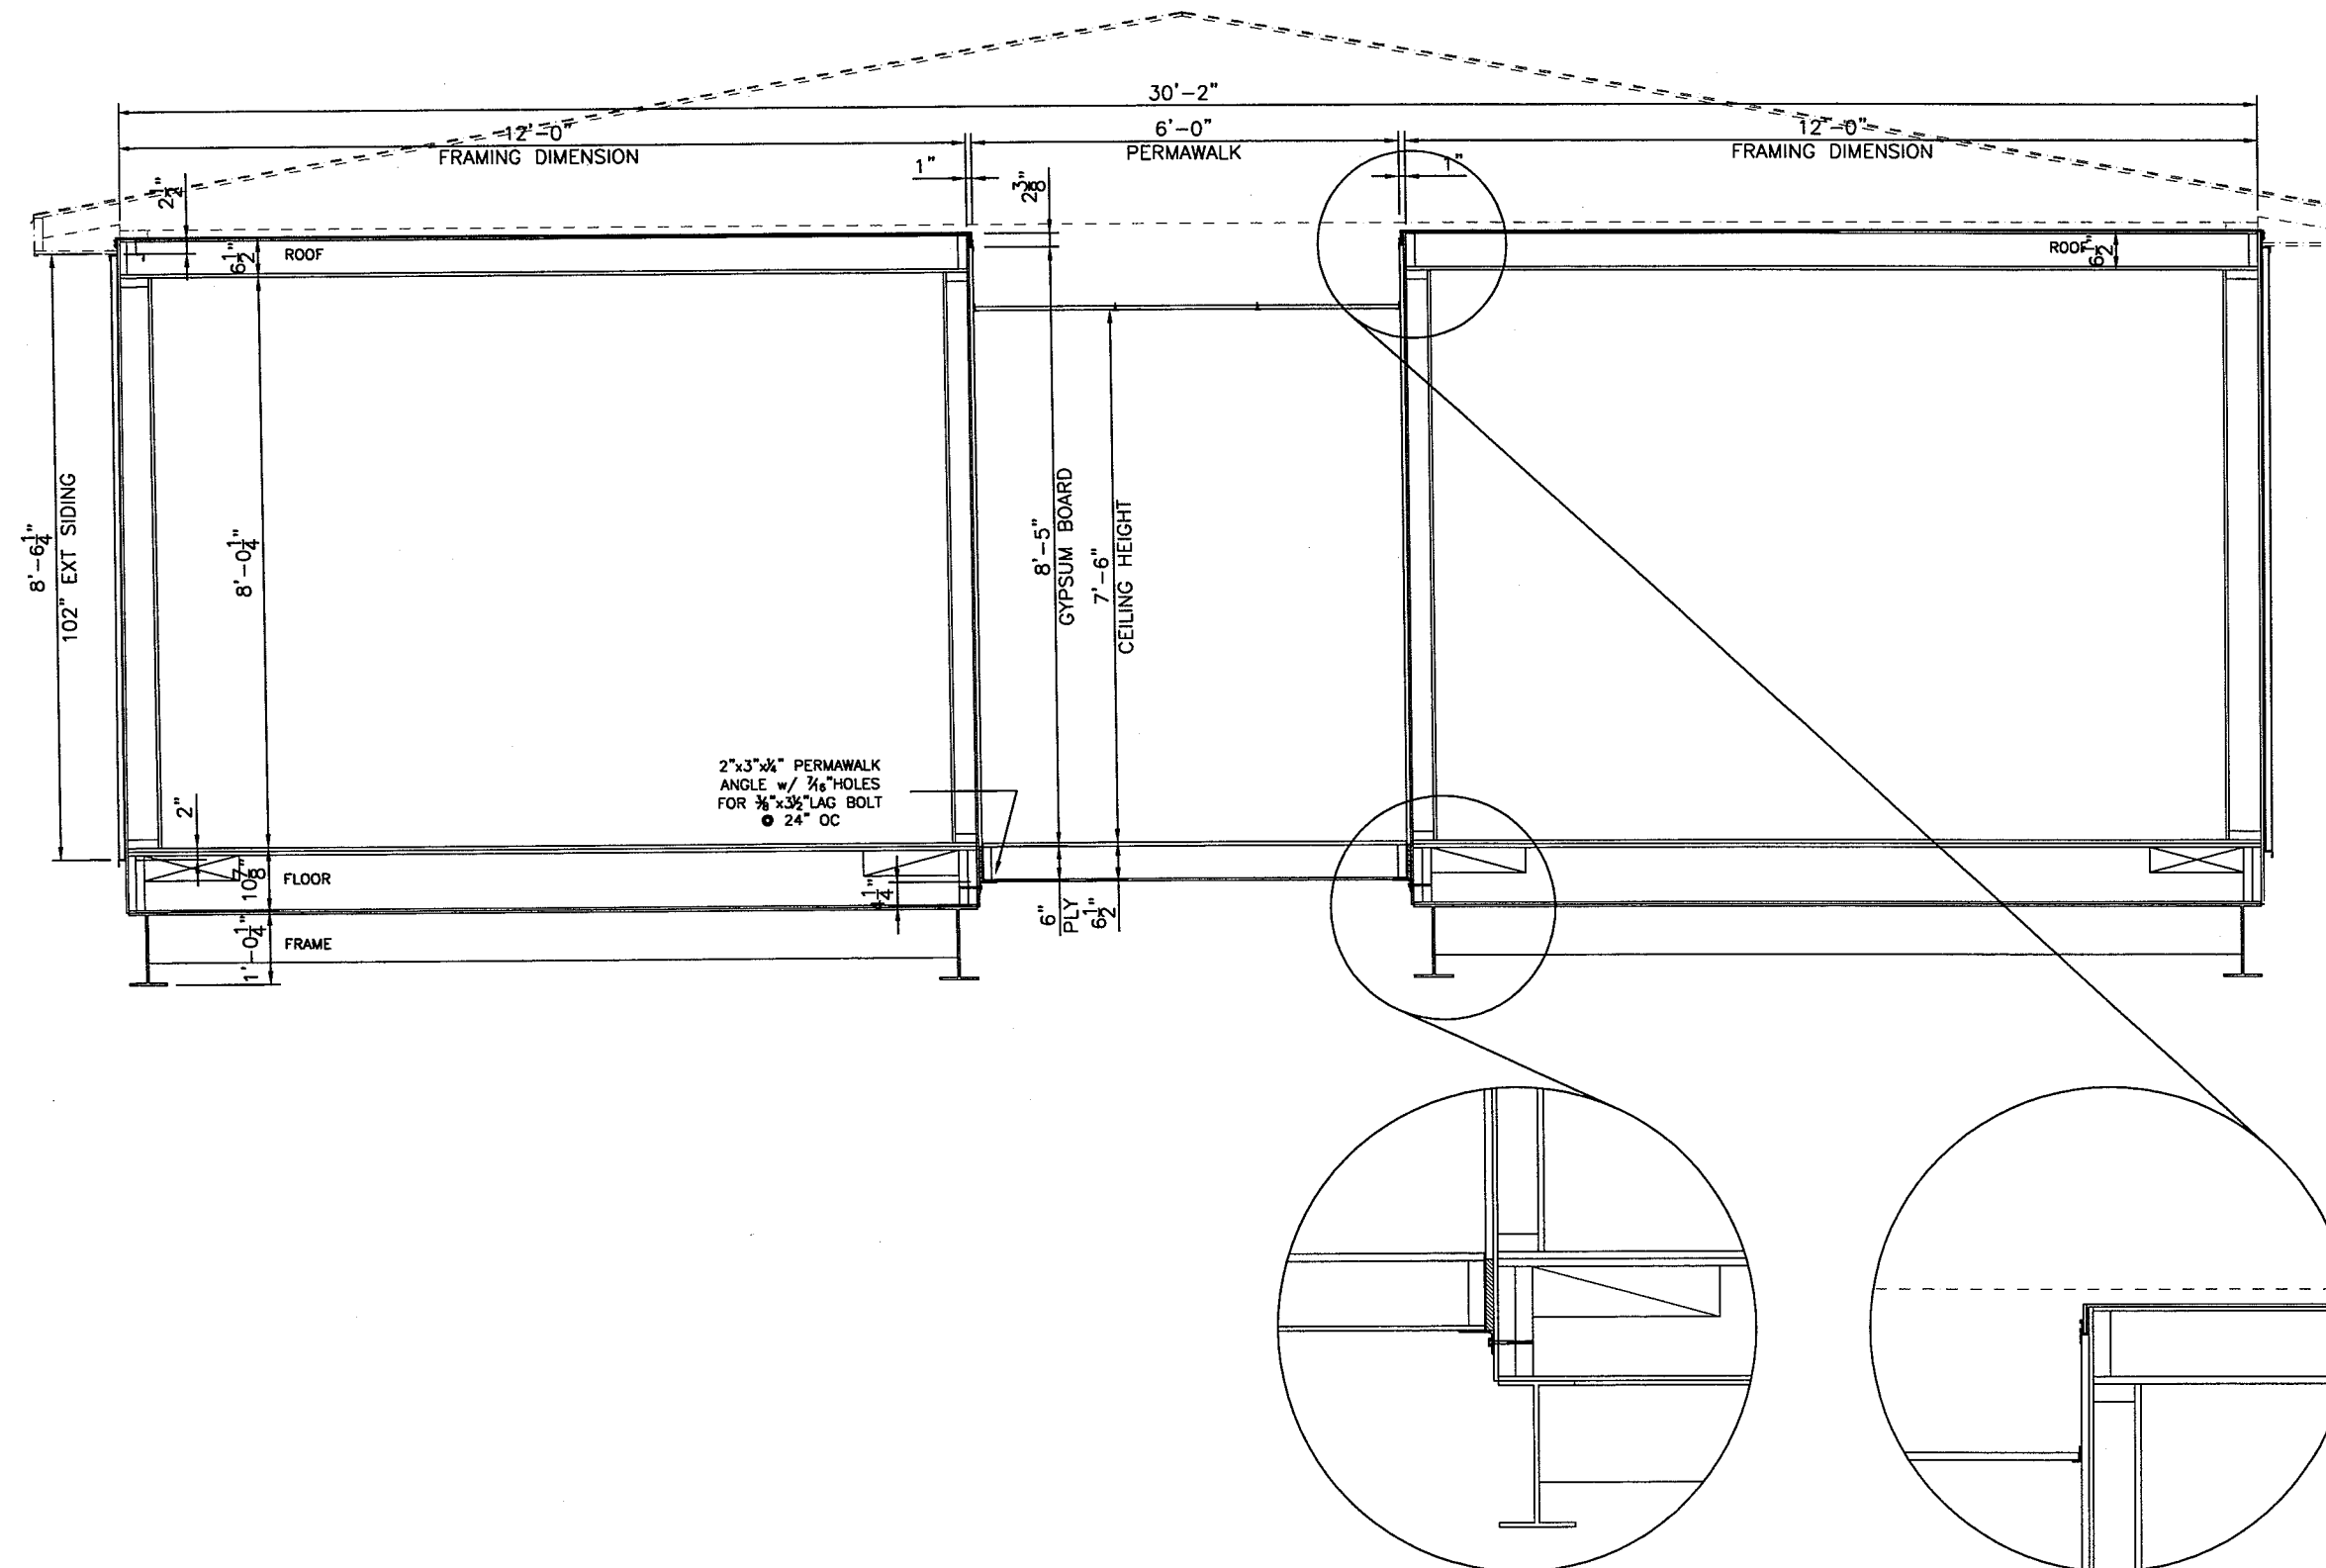

REV	DATE	DESCRIPTION	BY	CHK	APP
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DATE: \_\_\_\_\_

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 DATE: 15AUG05  
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 APPROVED BY: \_\_\_\_\_ DATE: \_\_\_\_\_


CLIENT: DEVON CANADA  
 54-PERSON PERMANENT CAMP  
 JACKFISH PROJECT

PROJECT: 6-12x56 UNIT DORM COMPLEX  
 [3-DORM COMPLEX]

**INTERNAL DOCUMENT CONTROL**

PLANT REDLINES BY: \_\_\_\_\_ DATE: \_\_\_\_\_  
 REDLINE REC'D BY ENG BY: \_\_\_\_\_ DATE: \_\_\_\_\_  
 DRAWING TITLE: TYPICAL CROSS SECTION

DRAWING NO: B-95355-01-D01  
 REVISION: 0

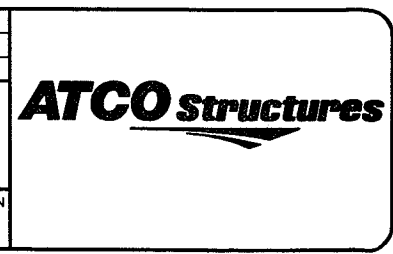






[illegible]

**NOTES:**

1. QUANTITIES ARE FOR ONE DORM UNIT [x6 PER COMPLEX] EXCEPT OF DOOR #101A & 101B-PER COMPLEX
2. EXTERIOR LOCK ALL KEYED ALIKE, CLIENT MASTER
3. KEYED DIFFERENT, CLIENT MASTER
4. KEYED ALIKE, CLIENT MASTER
5. BOTTOM SWEEP, SOUND GASKET, ROOM NAME PLATE

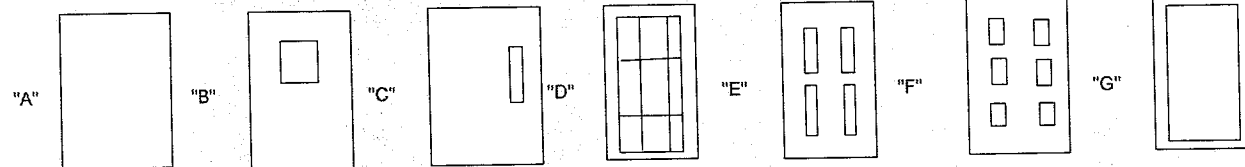

1. LOCKSET (KNOB)
2. LOCKSET (LEVERED)
3. PRIVACY (KNOB)
4. PRIVACY (LEVERED)
5. PASSAGE (KNOB)
6. PASSAGE (LEVERED)

8. PANIC 9898STS (ENT./EXIT)
9. PANIC 2828 (EXIT ONLY)
10. PANIC 9763 (VERT. ROD) DOUBLE DRS.
11. PANIC 644 (STRIKER) DOUBLE DRS.
12. KICK PLATES 34X10
13. KICK PLATES 30X10

- 14.CLOSERS - CALROYAL 430P  
15.CLOSERS - 1461LCN DELAYED HAND.  
16.CHECK CHAIN W/ VINYL SLEEVE  
17.COOLER/FREEZER KASON K58SFBS  
18.DOOR STOP  
19. CYLINDER LOCK  
20.COORDINATOR

- 21.T-LATCH DOOR HOLDER  
22.SHIPPING LATCH  
23.DEADBOLT  
24.SPRING BOLT  
25.D-PULL  
26. PUSH/PULL  
27. BARREL BOLT

[illegible]

0	29-Aug-05	ISSUE FOR ACCEPTANCE	EM		
REV	DATE	DESCRIPTION	BY	CHK	APP

### Client Acceptance Issue

AUG 29 2005

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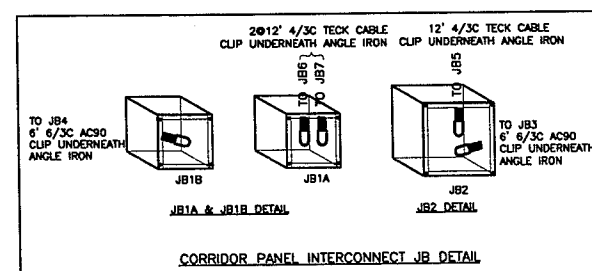
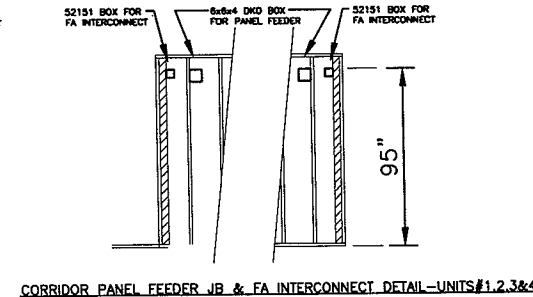
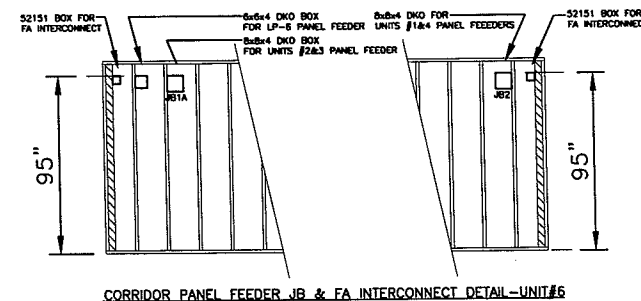
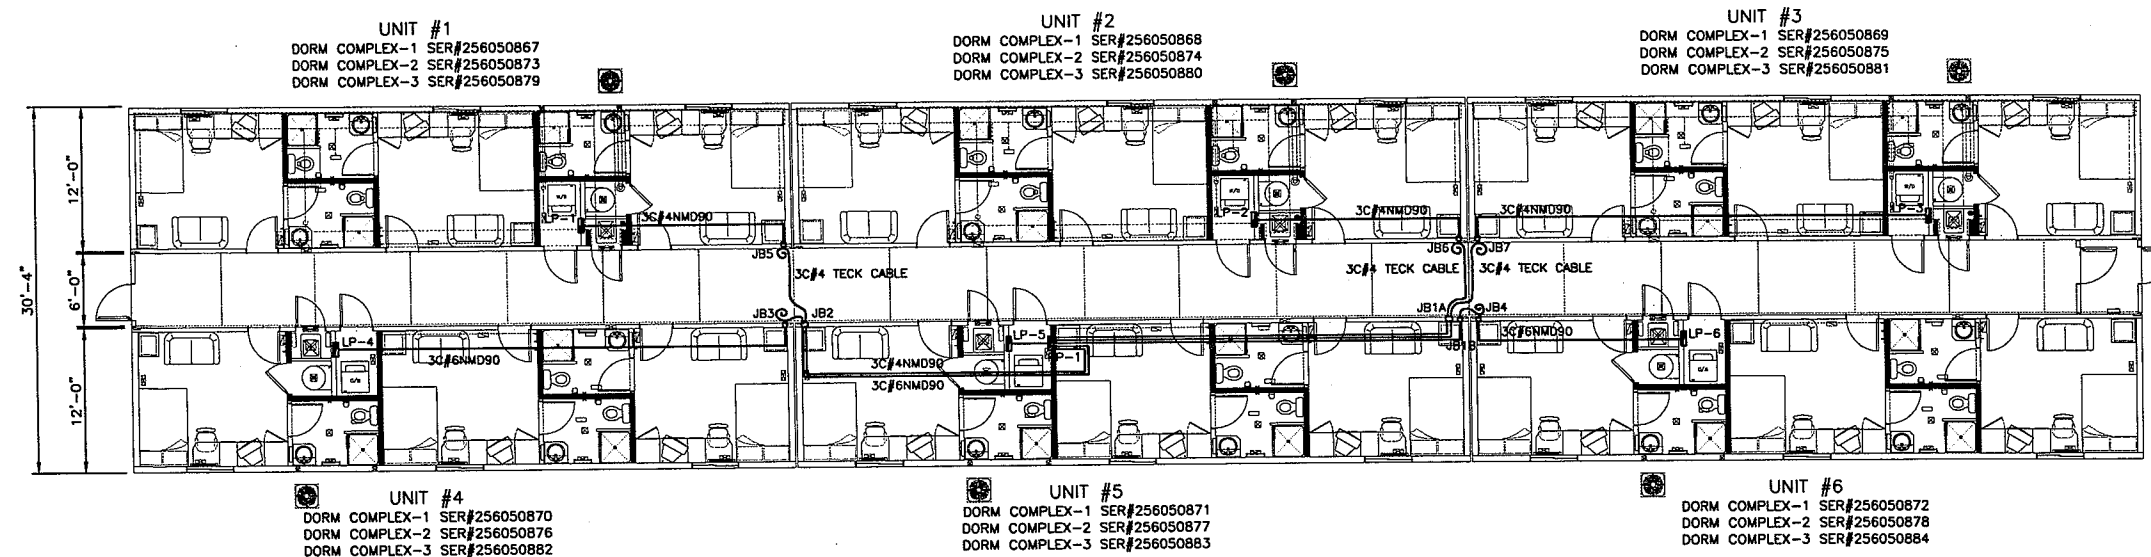
DEVON CANADA  
54-PERSON PERMANENT CAMP  
JACKFISH PROJECT

PROJECT:  
6-12x56 UNIT DORM COMPLEX  
[3-DORM COMPLEX]

DRAWING TITLE:  
DOOR & WINDOW SCHEDULE  
DORMITORY


DRAWING NO:	REVISION:
B-95355-01-XL03	0

## ATCO Structures



PANEL SCHEDULE							
PANEL #	PP-1	PANEL TYPE	P1B4A2-24ED				
MOUNTING	SEMI-FLUSH	VOLTAGE	120/208V				
TOTAL LOAD	55kW[EST. DEMAND LOAD]	PHASE:	3ø 4W				
FED FROM	BY CLIENT	MAIN BREAKER	3P200A				
FEEDER	BY CLIENT						
STUBS	2" STUB DOWN + 3ø1" EMT STUB DOWN S						
WATTS	DESCRIPTION	No	C/B	C/B	No	DESCRIPTION	WATTS
11.5kW	LP-1	1	2P	2P	2	LP-4	8kW
		3	70	50	4		
11.5kW	LP-2	5	2P	2P	6	LP-5	8kW
		7	70	50	8		
11.5kW	LP-3	9	2P	2P	10	LP-6	8kW
		11	70	50	12		
		13			14		
		15			16		
		17			18		
		19			20		
		21			22		
		23			24		

PLANT TO INSTALL PIGTAILS ON JB1 AND JB1A AND PROVIDE ENOUGH CABLE SLACK FOR INTERCONNECT. PIGTAILS TO HAVE AC90/TECK CONNECTORS ON OTHER END FOR SITE CONNECTION.

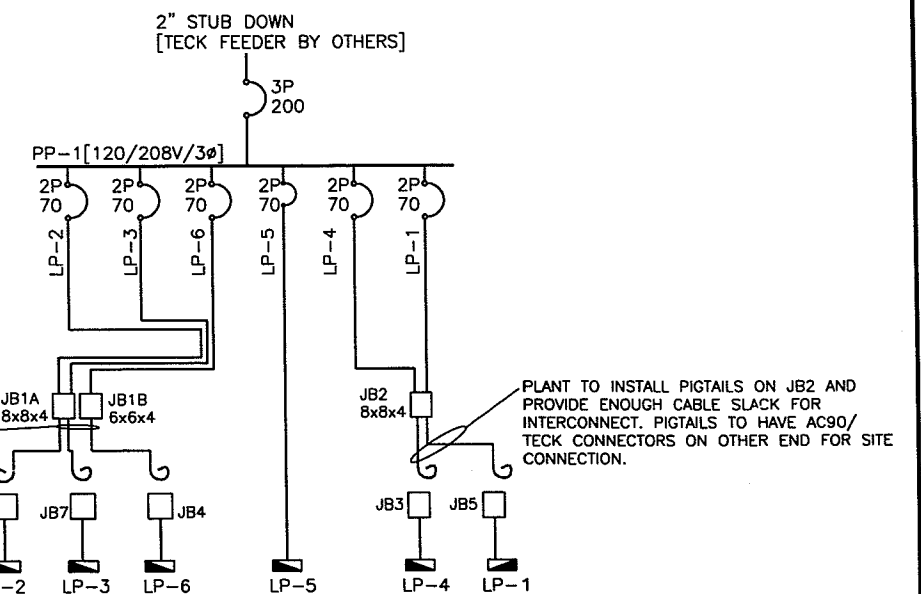

PANEL WIRING FEEDERS - BLOCK DIAGRAM

NOTES:

- ALL FEEDER WIRING WITHIN UNIT #1, #2, #3 TO BE 3C#4 NMD90.
- ALL FEEDER WIRING WITHIN UNIT #4, #5, #6 TO BE 3C#6 NMD90.
- ALL FEEDER WIRING IN PERMAWALK TO BE 3C#6 AC90 UNLESS SPECIFIED.
- AC90/TECK CABLE TO BE SECURED WITH CABLE CLIPS.
- ALL JB'S SHALL BE 6x6x4 DKO UNLESS OTHERWISE NOTED.

PANELBOARDS	
DORM COMPLEX-1	PP-1
DORM COMPLEX-2	PP-2
DORM COMPLEX-3	PP-3

REV	DATE	DESCRIPTION	BY	CHK	APP
1	29JUL05	ISSUE FOR ACCEPTANCE	ASMD		

NOTES:

Client Acceptance Issue

AUG 29 2005

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BY: \_\_\_\_\_

DATE: \_\_\_\_\_

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DRAWN BY: ASMD  
DATE: JULY 2005  
SCALE: 1/8"=1'-0"  
CHECKED BY: *mf* DATE: 9/6/05  
APPROVED BY: *AS* DATE: 9/6/05


CLIENT: DEVON CANADA  
54-PERSON PERMANENT CAMP  
JACKFISH PROJECT

PROJECT: 6-12x56 UNIT DORM COMPLEX  
[3-DORM COMPLEX]

INTERNAL DOCUMENT CONTROL	
PLANT REDLINES BY: _____	DATE: _____
REDLINE REC'D BY ENG BY: _____	DATE: _____
DRAWING TITLE: ELECTRICAL DISTRIBUTION LAYOUT	
DRAWING NO: D-95355-01-E01	REVISION: Ø

**ATCO Structures**



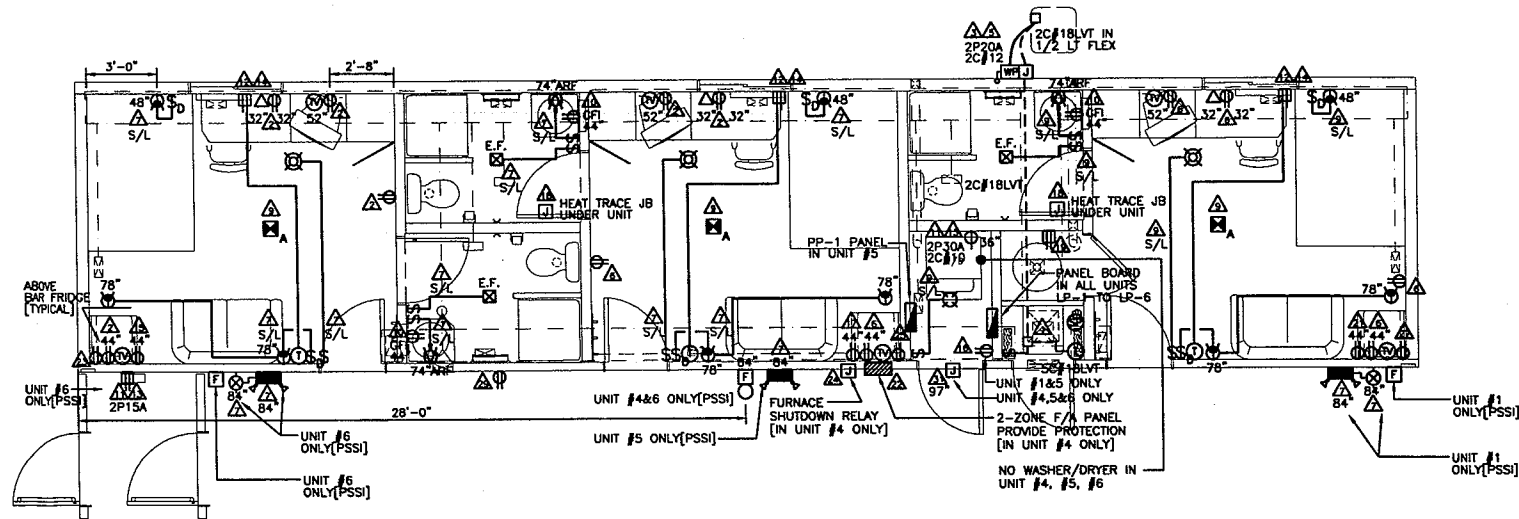

**LEGEND**

- 2xPL13 CEILING FIXT. W/ ACRYLIC DOME DIFFUSER, RUSSELL #CF383-114/2
- EXT. RWG-100 60W INCANDESCENT FIXTUREC/W 60W BULB
- 1x60W CEILING FIXTURE WITH WHITE BASE AND 6" LEXAN GLOBE
- 2x 60W INCANDESCENT VANITY LIGHT
- BUNK LIGHT - RUSSELL #730-112
- 15A/125V SINGLE POLE SWITCH-WHITE
- WEATHER PROOF DISCONNECT SIZE AS SHOWN ON DWG.
- JUNCTION BOX SIZE AS REQUIRED
- 15A/125V DUPLEX RECEPTACLE-WHITE
- 15A/125V GROUND FAULT DUPLEX RECEPTACLE-WHITE
- SINGLE RECEPTACLE, SIZE INDICATED ON DWG.
- HARD WIRED CONNECTION
- POWER PANEL
- TELEPHONE OUTLET WITH 3/4" PVC CONDUIT STUB DOWN & BLANK PLATE
- AUTO CHANGE-OVER THERMOSTAT
- TV OUTLET C/W RG-6 CABLE WIRED BACK TO SPLITTER
- 6 WAY SPLITTER
- EXIT LIGHT SIGN
- COMBINATION EXIT/EMERGENCY LIGHT PACK WITH 2 HEADS 36W
- EMERGENCY LIGHT PACK WITH 2 HEADS 36W
- TWO(2) ZONE MAIN FIRE ALARM PANEL C/W BATTERY BACKUP - NOTIFIER CFP-2402B
- 120VAC SMOKE ALARM
- 6", 24 VDC MOTOR DRIVEN BELL - NOTIFIER
- MANUAL BREAK GLASS STATION - NOTIFIER
- AC90(BX) CABLE 1/2" OR AS NOTED
- NMD90 LOOMEX CABLE 1/2" OR AS NOTED

PANEL SCHEDULE

PANEL #	LP-1	PANEL TYPE	CPL116
MOUNTING	FLUSH	VOLTAGE	120/208V
TOTAL LOAD	11.5KW[EST. DEMAND LOAD]	PHASE	1Ø 3W
FED FROM	PP-1	MAIN BREAKER	NONE[2P70A IN PP-1]
FEEDER	3C#4 NMD90 TO JB5		
STUBS	1/2" EMT[GND] STUB DOWNS		

WATTS	DESCRIPTION	No	C/B	C/B	No	DESCRIPTION	WATTS
400	FURNACE	1	15	1P	2	BEDROOM RECEPTACLES	1200
2400	A/C	3	2P	1S	4		
		5	20	1P	6	BEDROOM RECEPTACLES	1200
1057	LIGHTS	7	15	1S	8		
846	LIGHTS	9	15	1S	10	GFI RECEPTACLES	600
5000	WASHER/DRYER	11	2P	2P	12	BASEBOARD HEATER	1500
		13	30	1S	14		
400	COUNTER RECEPTACLE	15	15	1S	16	RECEPTACLE	200
400	COUNTER RECEPTACLE	17	15	1P	18	HEAT TRACE JB	200
100	WATER HEATER	19	15	1S	20		
400	COUNTER RECEPTACLE	21	15		22		
400	FRIDGE	23	15		24		
400	FRIDGE	25	15		26		
400	FRIDGE	27	15		28		
400	CORRIDOR RECEPTACLE	29	15		30		
	SPARE	31	15		32		

PANEL SCHEDULE

PANEL #	LP-3	PANEL TYPE	CPL116				
MOUNTING	FLUSH	VOLTAGE	120/208V				
TOTAL LOAD	11.5KW(EST. DEMAND LOAD)	PHASE:	1Ø 3W				
FED FROM	PP-1	MAIN BREAKER	NONE[2P70A IN PP-1]				
FEEDER	3C#4 NMD90 TO JB7						
STUBS	1/2" EMT[GND] STUB DOWNS						
WATTS	DESCRIPTION	No	C/B	C/B	No	DESCRIPTION	WATTS
400	FURNACE	1	15	1P	2	BEDROOM RECEPTACLES	1200
2400	A/C	3	2P	1S	4		
		5	20	1P	6	BEDROOM RECEPTACLES	1200
1057	LIGHTS	7	15	1S	8		
846	LIGHTS	9	15	1S	10	GFI RECEPTACLES	600
5000	WASHER/DRYER	11	2P	2P	12	BASEBOARD HEATER	1500
		13	30	1S	14		
400	COUNTER RECEPTACLE	15	15	1S	16	SPARE	
400	COUNTER RECEPTACLE	17	15	1P	18	HEAT TRACE JB	200
100	WATER HEATER	19	15	1S	20		
400	COUNTER RECEPTACLE	21	15		22		
400	FRIDGE	23	15		24		
400	FRIDGE	25	15		26		
400	FRIDGE	27	15		28		
400	CORRIDOR RECEPTACLE	29	15		30		
	SPARE	31	15		32		

PANEL SCHEDULE

PANEL #	LP-5	PANEL TYPE	CPL116				
MOUNTING	FLUSH	VOLTAGE	120/208V				
TOTAL LOAD	8KW[EST. DEMAND LOAD]	PHASE	1Ø 3W				
FED FROM	PP-1	MAIN BREAKER	NONE[2P50A IN PP-1]				
FEEDER	3C#6 NMD90 TO JB3						
STUBS	1/2" EMT[GND] STUB DOWNS						
WATTS	DESCRIPTION	No	C/B	C/B	No	DESCRIPTION	WATTS
400	FURNACE	1	15	1P	2	BEDROOM RECEPTACLES	1200
2400	A/C	3	2P	1S	4		
		5	20	1P	6	BEDROOM RECEPTACLES	1200
1057	LIGHTS	7	15	1S	8		
846	LIGHTS	9	15	1S	10	GFI RECEPTACLES	600
	SPARE	11	15	2P	12	BASEBOARD HEATER	1500
	SPARE	13	15	1S	14		
400	COUNTER RECEPTACLE	15	15	1S	16	RECEPTACLE	200
400	COUNTER RECEPTACLE	17	15	1P	18	HEAT TRACE JB	200
100	WATER HEATER	19	15	1S	20		
400	COUNTER RECEPTACLE	21	15		22		
400	FRIDGE	23	15		24		
400	FRIDGE	25	15		26		
400	FRIDGE	27	15		28		
400	CORRIDOR RECEPTACLE	29	15		30		
	CORRIDOR LIGHTS	31	15		32		

PANEL SCHEDULE

PANEL #	LP-2	PANEL TYPE	CPL116
MOUNTING	FLUSH	VOLTAGE	120/208V
TOTAL LOAD	11.5KW[EST. DEMAND LOAD]	PHASE	1Ø 3W
FED FROM	PP-1	MAIN BREAKER	NONE[2P70A IN PP-1]
FEEDER	3C#4 NMD90 TO JB6		
STUBS	1/2" EMT[GND] STUB DOWNS		

WATTS	DESCRIPTION	No	C/B	C/B	No	DESCRIPTION	WATTS
400	FURNACE	1	15	1P	2	BEDROOM RECEPTACLES	1200
2400	A/C	3	2P	1S	4		
		5	20	1P	6	BEDROOM RECEPTACLES	1200
1057	LIGHTS	7	15	1S	8		
846	LIGHTS	9	15	1S	10	GFI RECEPTACLES	600
5000	WASHER/DRYER	11	2P	2P	12	BASEBOARD HEATER	1500
		13	30	1S	14		
400	COUNTER RECEPTACLE	15	15	1S	16	SPARE	
400	COUNTER RECEPTACLE	17	15	1P	18	HEAT TRACE JB	200
100	WATER HEATER	19	15	1S	20		
400	COUNTER RECEPTACLE	21	15		22		
400	FRIDGE	23	15		24		
400	FRIDGE	25	15		26		
400	FRIDGE	27	15		28		
400	CORRIDOR RECEPTACLE	29	15		30		
	SPARE	31	15		32		

PANEL SCHEDULE


PANEL #	LP-4	PANEL TYPE	CPL116				
MOUNTING	FLUSH	VOLTAGE	120/208V				
TOTAL LOAD	8KW[EST. DEMAND LOAD]	PHASE:	1Ø 3W				
FED FROM	PP-1	MAIN BREAKER	NONE[2P50A IN PP-1]				
FEEDER	3C#6 NMD90 TO JB3						
STUBS	1/2" EMT[GND] STUB DOWNS						
WATTS	DESCRIPTION	No	C/B	C/B	No	DESCRIPTION	WATTS
400	FURNACE	1	15	1P	2	BEDROOM RECEPTACLES	1200
2400	A/C	3	2P	1S	4		
		5	20	1P	6	BEDROOM RECEPTACLES	1200
1057	LIGHTS	7	15	1S	8		
846	LIGHTS	9	15	1S	10	GFI RECEPTACLES	600
	SPARE	11	15	2P	12	BASEBOARD HEATER	1500
	SPARE	13	15	1S	14		
400	COUNTER RECEPTACLE	15	15	1S	16	SPARE	
400	COUNTER RECEPTACLE	17	15	1P	18	HEAT TRACE JB	200
100	WATER HEATER	19	15	1S	20		
400	COUNTER RECEPTACLE	21	15	1S	22	FIRE ALARM PANEL	50
400	FRIDGE	23	15	1S	24	FURNACE SHUTDOWN RELAY	100
400	FRIDGE	25	15		26		
400	FRIDGE	27	15		28		
400	CORRIDOR RECEPTACLE	29	15		30		
	CORRIDOR LIGHTS	31	15		32		

PANEL SCHEDULE

PANEL #	LP-6	PANEL TYPE	CPL116				
MOUNTING	FLUSH	VOLTAGE	120/208V				
TOTAL LOAD	8kW[EST. DEMAND LOAD]	PHASE	1Ø 3W				
FED FROM	PP-1	MAIN BREAKER	NONE[2P50A IN PP-1]				
FEEDER	3C#6 NMD90 TO JB3						
STUBS	1/2" EMT[GND] STUB DOWNS						
WATTS	DESCRIPTION	No	C/B	C/B	No	DESCRIPTION	WATTS
400	FURNACE	1	15	1P	2	BEDROOM RECEPTACLES	1200
2400	A/C	3	2P	1S	4		
		5	20	1P	6	BEDROOM RECEPTACLES	1200
1057	LIGHTS	7	15	1S	8		
846	LIGHTS	9	15	1S	10	GFI RECEPTACLES	600
2000	FORCEFLOW HEATER	11	2P	2P	12	BASEBOARD HEATER	1500
		13	1S	1S	14		
400	COUNTER RECEPTACLE	15	15	1S	16	SPARE	
400	COUNTER RECEPTACLE	17	15	1P	18	HEAT TRACE JB	200
100	WATER HEATER	19	15	1S	20		
400	COUNTER RECEPTACLE	21	15		22		
400	FRIDGE	23	15		24		
400	FRIDGE	25	15		26		
400	FRIDGE	27	15		28		
400	CORRIDOR RECEPTACLE	29	15		30		
	CORRIDOR LIGHTS	31	15		32		

\* - CUTLER-HAMMER 30mA GROUND FAULT CIRCUIT BREAKER

- NOTES:**
- ALL WIRE TO BE 2#14 NMD90 UNLESS OTHERWISE NOTED.
  - ALL ELECTRICAL CONNECTIONS TO BE MOUNTED 16" ABOVE FINISHED FLOOR (AFF) UNLESS OTHERWISE SPECIFIED.
  - ALL ELECTRICAL DEVICES ARE TO BE WHITE IN COLOR.
  - PROVIDE 610' CAT5E TELEPHONE CABLE FOR SITE INSTALLATION TO TELEPHONE OUTLETS. SHIP LOOSE IN TELECOM ROOM. ALL TELE/DATA INSTALLATIONS & TERMINATIONS BY CLIENT.
  - POWER PANEL TO BE C/W PANEL DOOR.
  - SEE DRAWING E01 FOR DISTRIBUTION WIRING DETAILS.
  - SEE DRAWING E03 FOR FIRE ALARM AND E04 FOR TV CABLE WIRING LAYOUTS. TV CABLES ARE TO BE TERMINATED IN THE FURNACE ROOM OF EACH UNIT TO TV SPLITTER.
  - ALL FIRE ALARM WIRING TO BE MULTI-CONDUCTOR SECUREX CABLE. IN FURNACE ROOMS WHERE 2#14 CABLE IS EXPOSED INSTALL FLEX OVER CABLE.

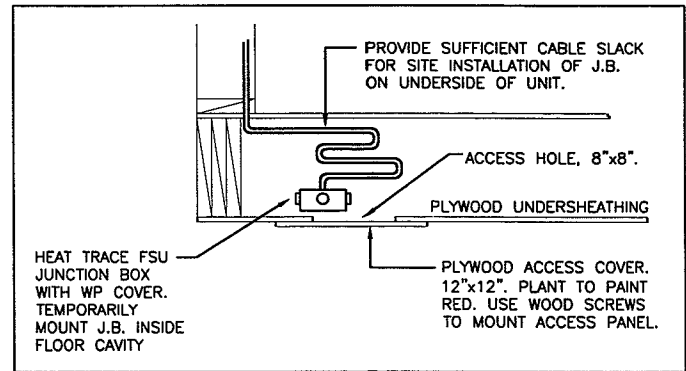


HEAT TRACE OUTLET DETAIL  
NTS

29JULY05 ISSUE FOR ACCEPTANCE REV DATE DESCRIPTION BY CHK APP		CLIENT: DEVON CANADA 54-PERSON PERMANENT CAMP JACKFISH PROJECT		INTERNAL DOCUMENT CONTROL PLANT REDLINES BY: DATE: REDLINE REC'D BY ENG BY: DATE: DRAWING TITLE: ELECTRICAL LAYOUT	
CUSTOMER ACCEPTANCE [ ] - ACCEPTANCE AS DRAWN [ ] - ACCEPTANCE EXCEPT AS NOTED BY: _____ DATE: _____		© COPYRIGHT 2000 ALL RIGHTS RESERVED DRAWN BY: ASMD DATE: JULY 2005 SCALE: 3/8" = 1'-0" CHECKED BY: [Signature] DATE: 29/07/05 APPROVED BY: [Signature] DATE: 02/08/05		PROJECT: 6-12x56 UNIT DORM COMPLEX [3-DORM COMPLEX]	
Client Acceptance Issue AUG 29 2005		DRAWING NO: D-95355--01-E02 REVISION: 0			





PERMAWALK 24HR LIGHTINGS(PSSI)

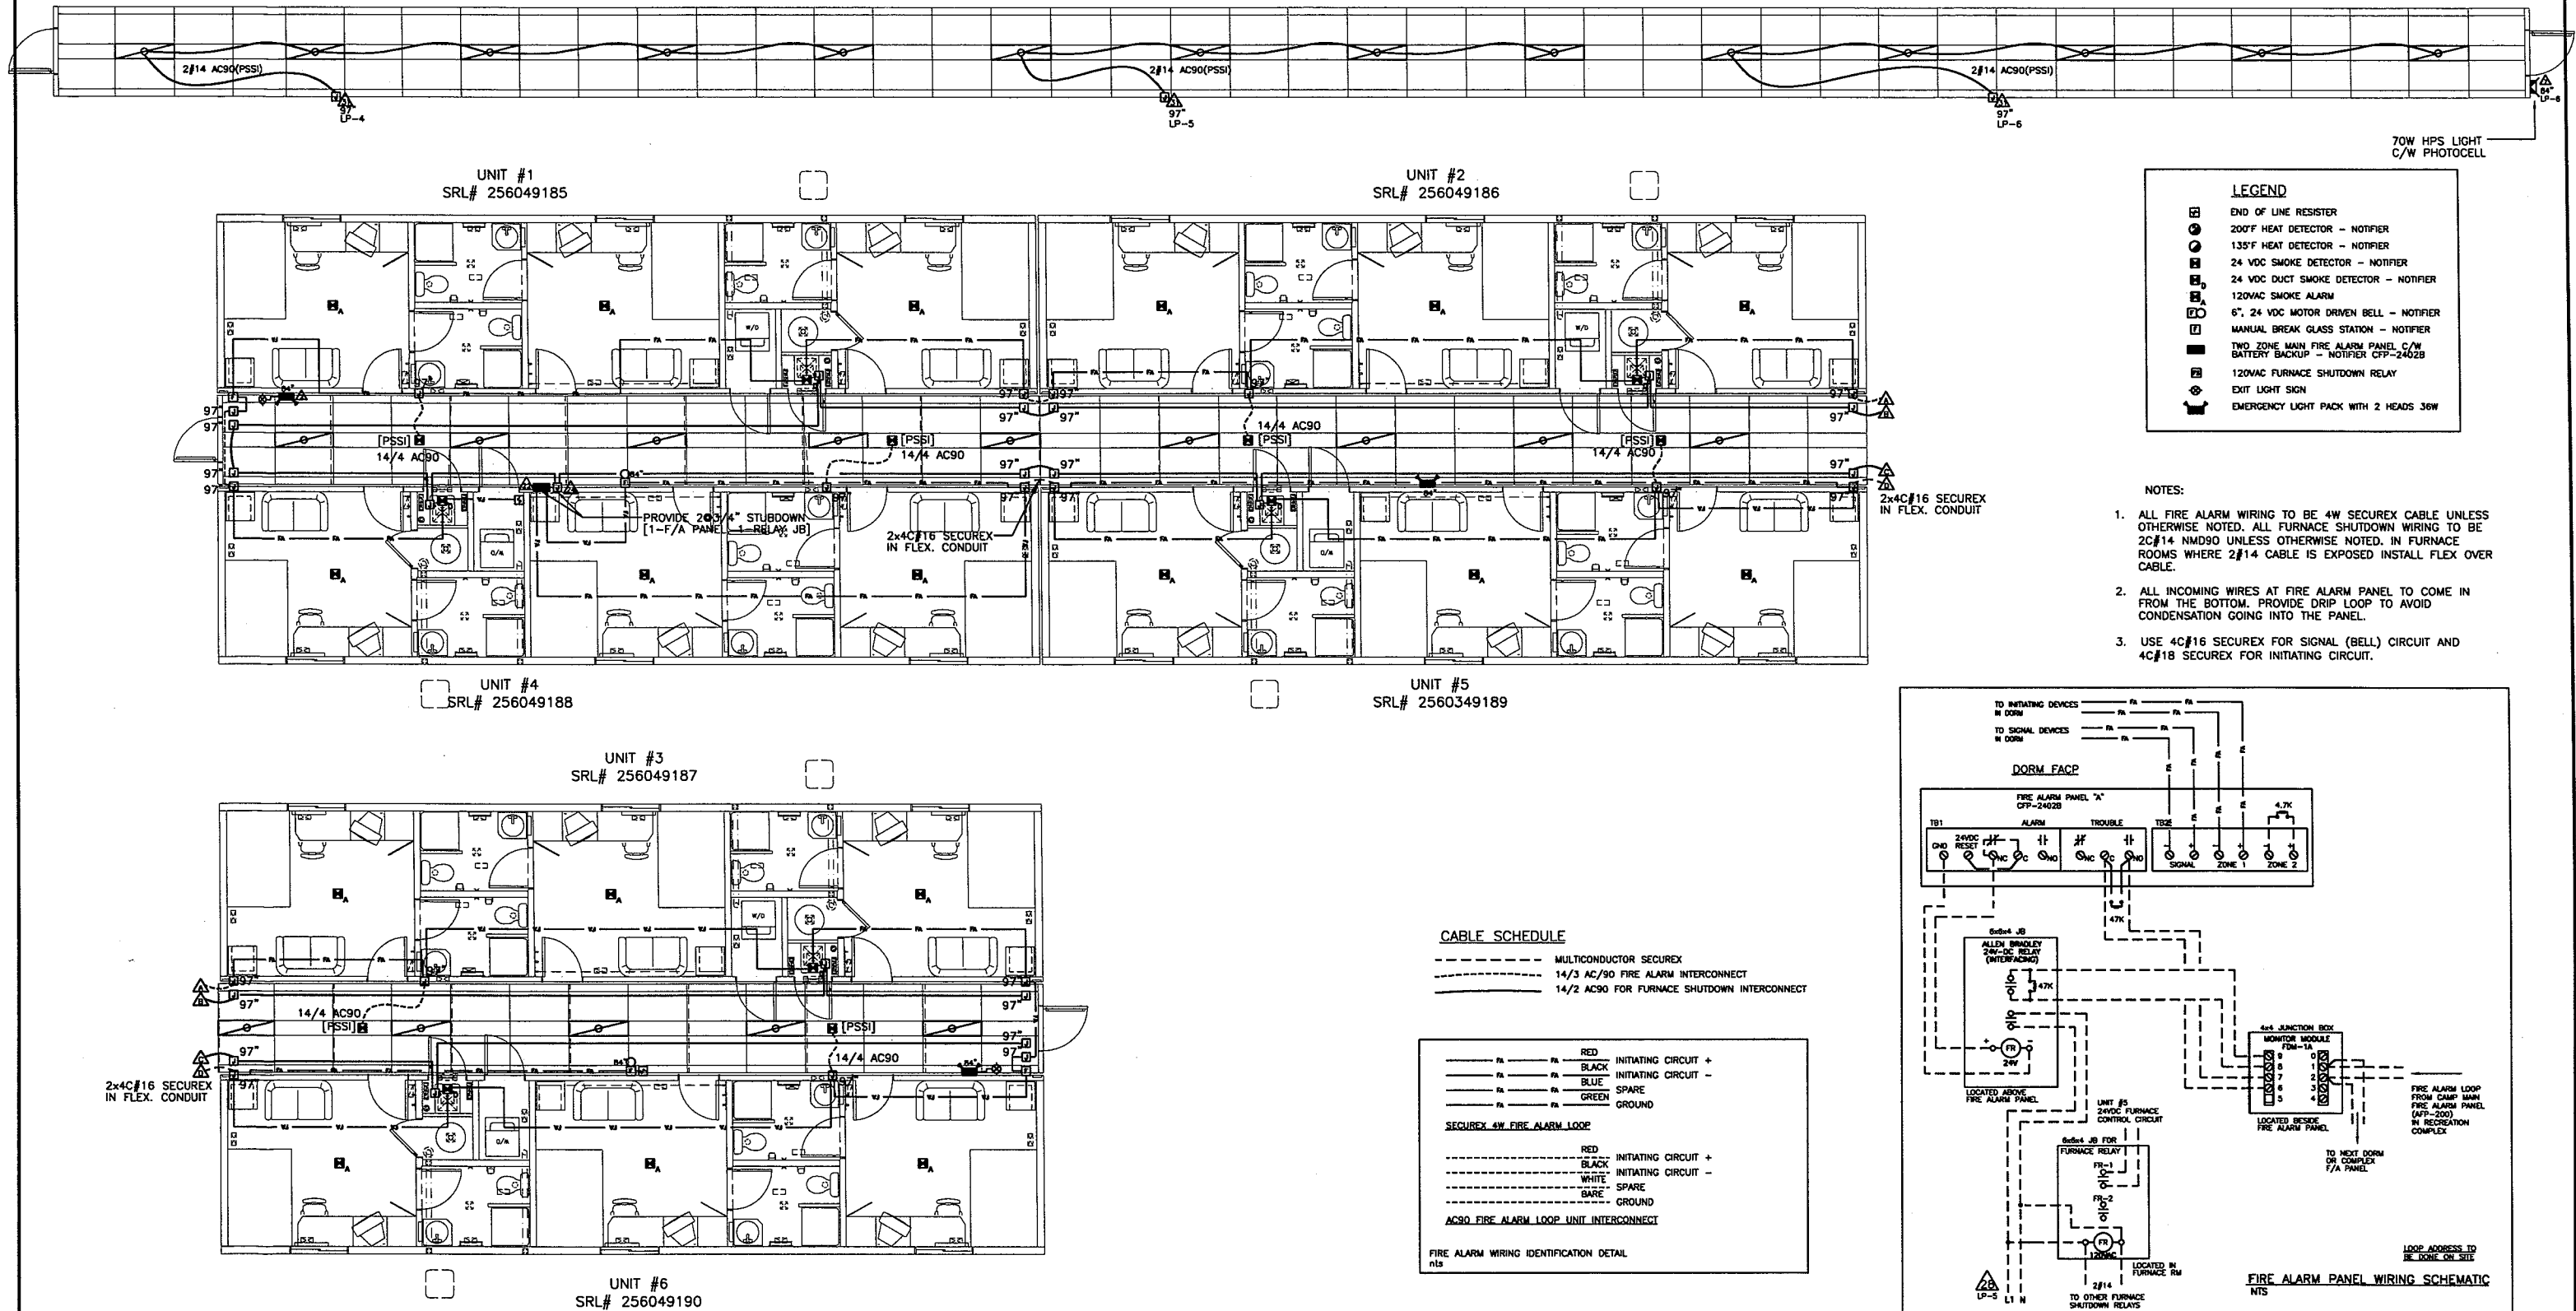

REV	DATE	DESCRIPTION	BY	CHK	APP
1	29JULY05	ISSUE FOR ACCEPTANCE	ASMD		

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AUG 29 2005

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DRAWN BY: ASMD

DATE: JULY 2005

SCALE: 3/16" = 1'-0"

CHECKED BY: *mm*

APPROVED BY: *AS*

DATE: 29/07/05

DATE: 02/08/05

CLIENT: DEVON CANADA  
54-PERSON PERMANENT CAMP  
JACKFISH PROJECT

PROJECT: 6-12x56 UNIT DORM COMPLEX  
[3-DORM COMPLEX]

INTERNAL DOCUMENT CONTROL

PLANT REDLINES BY: \_\_\_\_\_ DATE: \_\_\_\_\_  
REDLINE REC'D BY ENG BY: \_\_\_\_\_ DATE: \_\_\_\_\_  
DRAWING TITLE:



FIRE ALARM LAYOUT &  
PERMAWALK LIGHTINGS

DRAWING NO: D-95355--01-E03

REVISION

0

**ATCO** structures

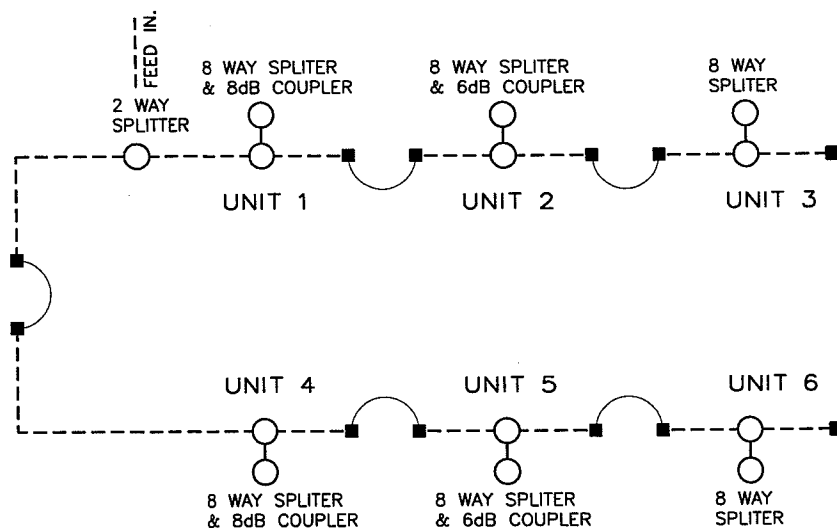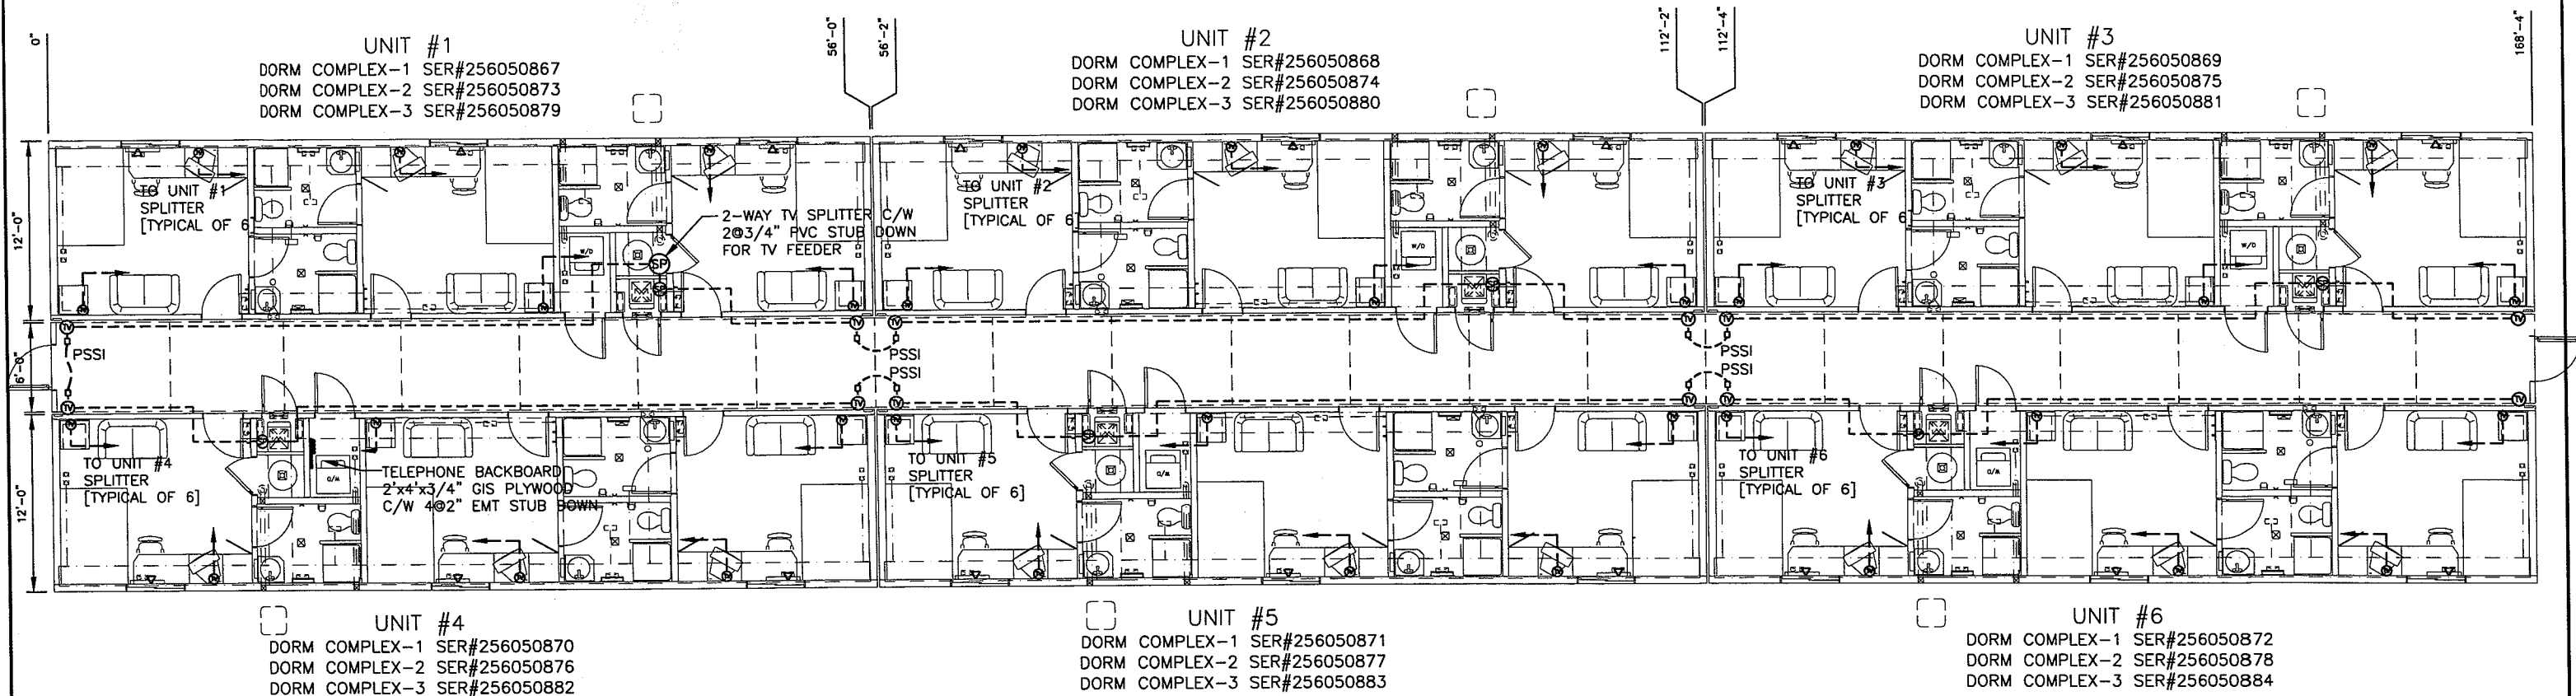

SCHEMATIC TELEVISION RISER

NOTES:

1. PROVIDE 610' CAT5E TELEPHONE CABLE FOR SITE INSTALLATION TO TELEPHONE OUTLETS. SHIP LOOSE IN TELECOM ROOM. ALL TELE/DATA INSTALLATIONS & TERMINATIONS BY CLIENT.
2. TELEVISION OUTLETS TO BE WIRED WITH RG-6 COAX CABLE BACK TO FURNACE ROOM AND INSTALLED INTO 8-WAY SPLITTER.
3. EACH TELEVISION OUTLET C/W PLATE AND F8 CONNECTOR.
4. PROVIDE A TV OUTLET CONNECTION AT EACH END OF EACH UNIT FOR TV CABLE INTERCONNECTION. OUTLETS TO CONSIST OF AN 1104 BOX C/W WHITE C/P & F8 CONNECTOR. OUTLETS TO BE LOCATED DIRECTLY BELOW THE FA INTERCONNECT OUTLET (@ APPROX. 98" AFF) AND MOUNTED HORIZONTALLY.
4. PROVIDE INTERCONNECT JUMPERS FOR TV CABLE BETWEEN. JUMPERS SHALL CONSIST OF RG-6 COAX CABLE C/W AN RG-6 CONNECTOR AT EITHER END. CABLE LENGTHS SHALL BE AS FOLLOWS:

(a) 5'0" BETWEEN UNITS 1-2, 2-3, 4-5 AND 5-6.

(b) 10'0" BETWEEN UNIT 1-4.

REV	DATE	DESCRIPTION	BY	CHK	APP
1	29JULY05	ISSUE FOR ACCEPTANCE	ASMD		

NOTES:

Client Acceptance Issue  
AUG 29 2005

CUSTOMER ACCEPTANCE

- ☐ - ACCEPTANCE AS DRAWN  
☐ - ACCEPTANCE EXCEPT AS NOTED

BY: \_\_\_\_\_  
DATE: \_\_\_\_\_

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DRAWN BY: ASMD  
DATE: JULY 2005  
SCALE: 3/16" = 1'-0"  
CHECKED BY: *WJS*  
APPROVED BY: *JS*

CLIENT:

DEVON CANADA  
54-PERSON PERMANENT CAMP  
JACKFISH PROJECT

PROJECT:

6-12x56 UNIT DORM COMPLEX  
[3-DORM COMPLEX]

INTERNAL DOCUMENT CONTROL


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REDLINE REC'D BY ENG BY: \_\_\_\_\_ DATE: \_\_\_\_\_  
DRAWING TITLE:

TELEPHONE & TV LAYOUT


DRAWING NO: D-95355--01-E04

REVISION  
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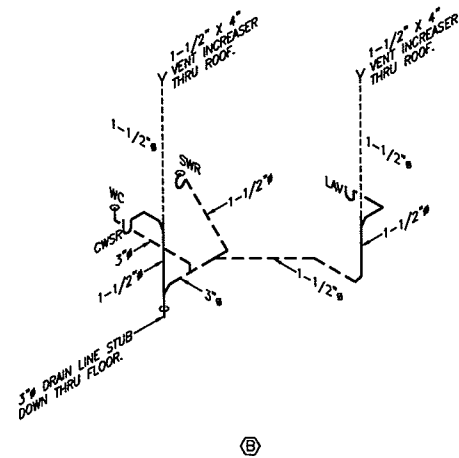
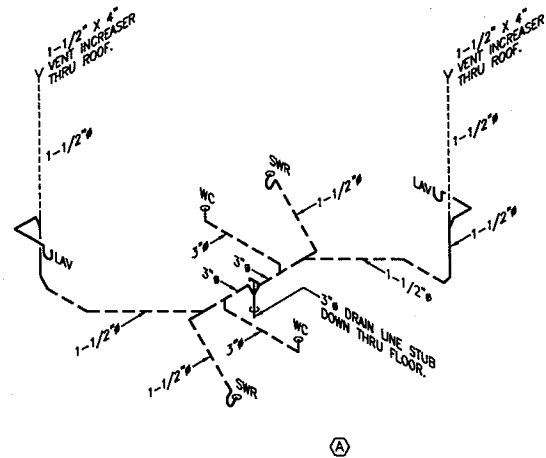
**ATCO structures**

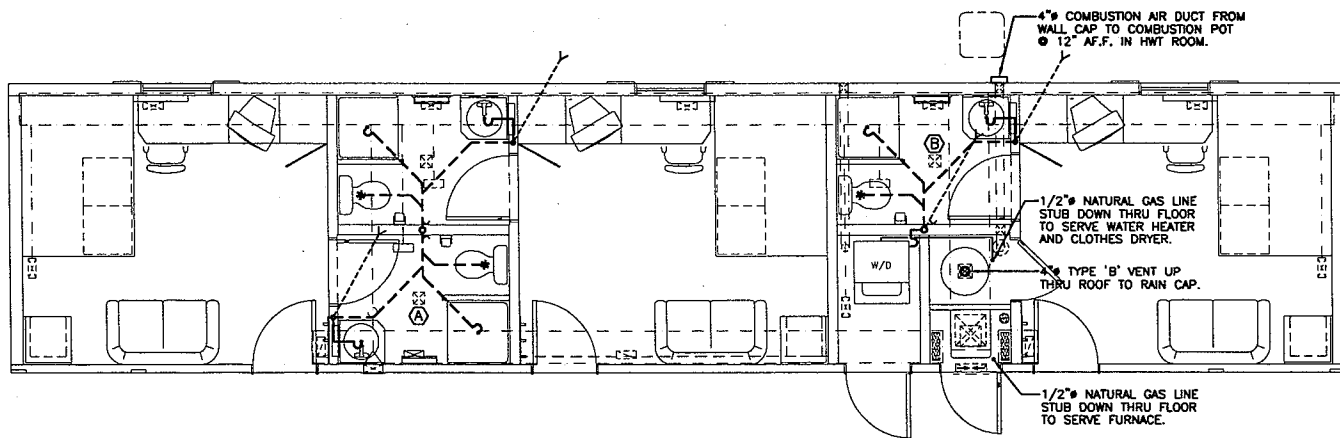


FLOOR PLAN - DRAINAGE & GAS PIPING  
SCALE: 1/4"=1'-0"

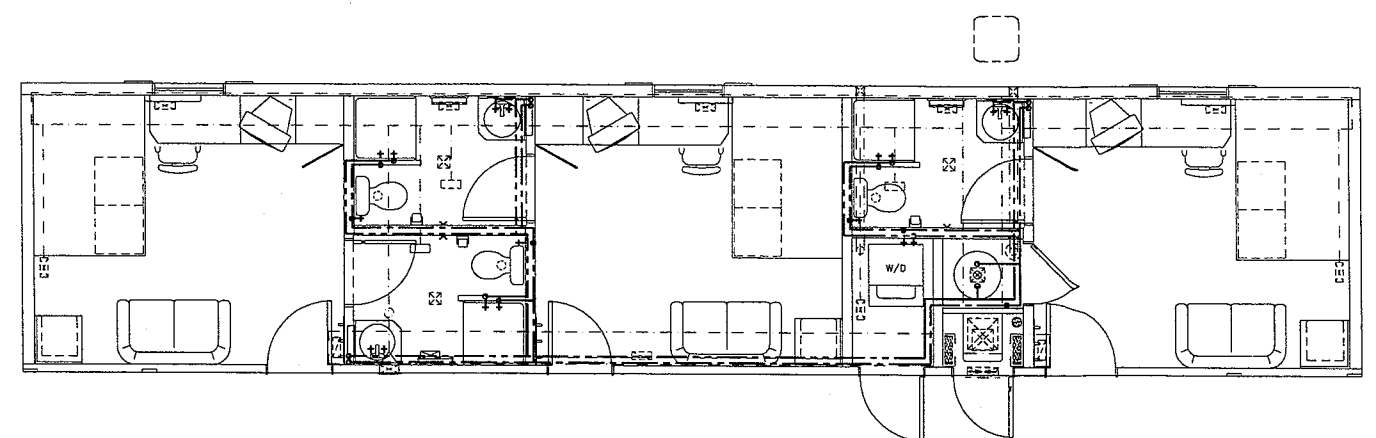

FLOOR PLAN - WATER PIPING  
SCALE: 1/4"=1'-0"



DRAINAGE PIPING SCHEMATICS  
- DRAIN LINES CONCEALED ABS.

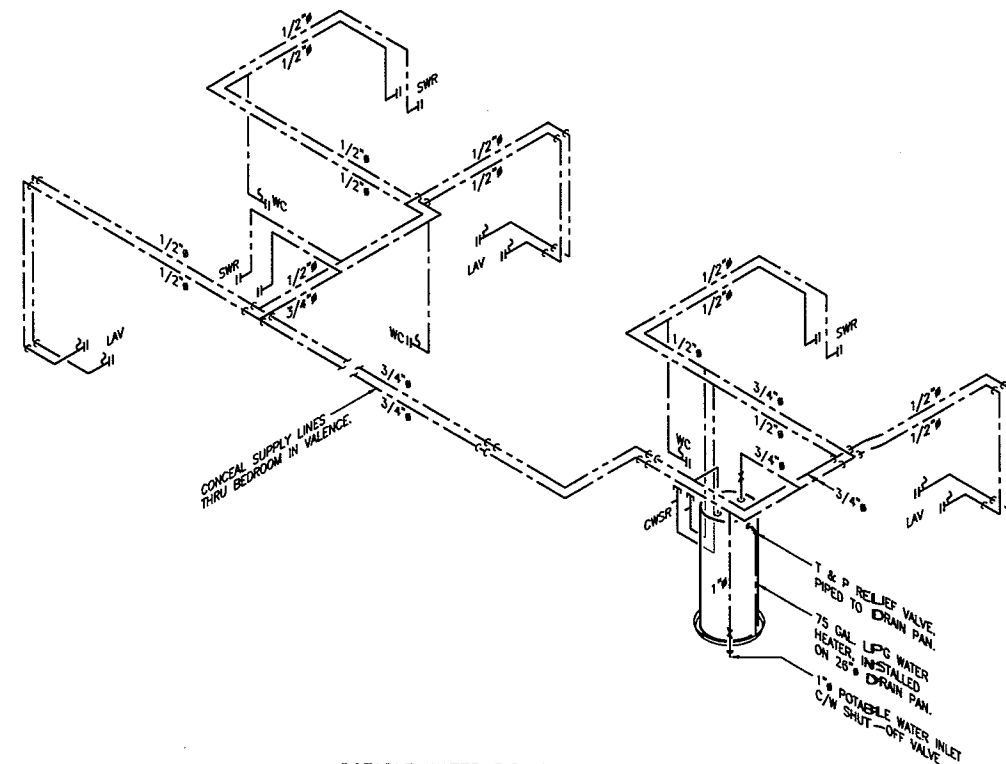

POTABLE WATER PIPING SCHEMATIC  
- WATER PIPING TO BE CONCEALED 'PEX' PIPE & FITTINGS.  
- SLOPE ALL PLUMBING LINES TO DRAIN AT LOW POINTS.

LEGEND

- DWV PIPING INSTALLED.
- DWV PIPING INSTALLED IN RAISED FLOOR.
- DWV VENT PIPING.

- WC - WATER CLOSET
- LAV - LAVATORY
- SWR - SHOWER
- CWSR - CLOTHES WASHER

SERIAL NUMBERS

UNIT #1 DORM COMPLEX-1 SER#256050867 DORM COMPLEX-2 SER#256050873 DORM COMPLEX-3 SER#256050879	UNIT #4 DORM COMPLEX-1 SER#256050870 DORM COMPLEX-2 SER#256050876 DORM COMPLEX-3 SER#256050882
UNIT #2 DORM COMPLEX-1 SER#256050868 DORM COMPLEX-2 SER#256050874 DORM COMPLEX-3 SER#256050880	UNIT #5 DORM COMPLEX-1 SER#256050871 DORM COMPLEX-2 SER#256050877 DORM COMPLEX-3 SER#256050883
UNIT #3 DORM COMPLEX-1 SER#256050869 DORM COMPLEX-2 SER#256050875 DORM COMPLEX-3 SER#256050881	UNIT #6 DORM COMPLEX-1 SER#256050872 DORM COMPLEX-2 SER#256050878 DORM COMPLEX-3 SER#256050884

LEGEND

- COLD WATER LINE
- HOT WATER LINE

- WC - WATER CLOSET
- LAV - LAVATORY
- SWR - SHOWER
- CWSR - CLOTHES WASHER

NOTES:

Client Acceptance Issue  
AUG 29 2005

CUSTOMER ACCEPTANCE

- ☐ - ACCEPTANCE AS DRAWN
- ☐ - ACCEPTANCE EXCEPT AS NOTED

BY: \_\_\_\_\_

DATE: \_\_\_\_\_

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DRAWN BY: MWB  
DATE: 29 JULY 05  
SCALE: 1/4"=1'-0"  
CHECKED BY: *[Signature]* DATE: 26/08/05  
APPROVED BY: *[Signature]* DATE: 26/08/05

CLIENT:

DEVON CANADA  
54 PERSON PERMANENT CAMP  
JACKFISH PROJECT

PROJECT:

6-12'X56' UNIT DORM COMPLEX

INTERNAL DOCUMENT CONTROL

PLANT REDLINES BY: \_\_\_\_\_ DATE: \_\_\_\_\_  
REDLINE REC'D BY ENG BY: \_\_\_\_\_ DATE: \_\_\_\_\_  
DRAWING TITLE:  
FLOOR PLAN - MECHANICAL

DRAWING NO:  
D-95355-01-M01

REVISION:  
0

**ATCO structures**

REV	DATE	DESCRIPTION	BY	CHK	APP
0	15AUG05	ISSUE FOR ACCEPTANCE	MWB		<i>[Signature]</i>